# **DISCLAIMER**

- 1. THE IMPROVISED HOSE REEL SYSTEM (DIRECT PUMPING DESIGN) ILLUSTRATED IN THIS SET OF SAMPLE DRAWINGS IS BASED ON A TARGET COMPOSITE BUILDING OF SIX STOREYS OR BELOW OR LESS THAN 20m IN HEIGHT IN CONNECTION WITH THE ANNOUNCEMENT OF FSD CIRCULAR LETTER NO. 4/2023, PART II.
- 2. THE SAMPLE DRAWINGS ARE AIMED AT PROVIDING GENERAL REFERENCE ON THE DRAWING FORMAT OF FSI/314C SUBMISSION UNDER THE FIRE SAFETY (BUILDINGS) ORDINANCE (CAP. 572), AND ARE NOT INTENDED FOR STIPULATING THE REQUIRED PROVISIONS/DESIGN OF FIRE SAFETY IMPROVEMENT WORKS WHICH VARY WITH EACH INDIVIDUAL CASE.
- 3. GIVEN THE NATURE OF THE SAMPLE DRAWINGS MENTIONED-ABOVE, THERE IS NO GUARANTEE THAT THE APPROVAL OF FSI/314C SUBMISSION ADOPTING THE SAMPLE DRAWINGS WILL BE OBTAINED.

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THE CONTENT AVAILABLE ON THIS SET OF SAMPLE DRAWINGS, INCLUDING BUT NOT LIMITED TO ALL TEXT, GRAPHICS, DRAWINGS AND DIAGRAMS ARE SUBJECT TO COPYRIGHT OWNED BY THE GOVERNMENT OF THE HONG KONG SPECIAL ADMINISTRATIVE REGION OR OTHER ENTITIES.

#### F.S. NOTES:

- 1. ALL FIRE SAFETY IMPROVEMENT WORKS SHALL BE PROVIDED IN ACCORDANCE WITH THE CODE OF PRACTICE FOR MINIMUM FIRE SERVICE INSTALLATIONS AND EQUIPMENT 1994 VERSION.
- 2. THE DESIGN AND SPECIFICATION OF IMPROVISED HR SYSTEM (DIRECT PUMPING DESIGN) SHALL COMPLY WITH APPENDIX VI OF FSD CIRCULAR LETTER NO. 4/2023.
- 3. A MANUAL FIRE ALARM SYSTEM SHALL BE PROVIDED IN ACCORDANCE WITH PARAGRAPH 5.11 & 5.14(i)(b) OF THE CODE OF PRACTICE FOR MINIMUM FIRE SERVICE INSTALLATIONS AND EQUIPMENT 1994 VERSION.
- 4. ALL FIRE SERVICE EQUIPMENT SHALL BE ENERGIZED BY PRIMARY AND SECONDARY POWER SUPPLY AND MANAGED BY AUTOMATIC CHANGOVER SWITCH WITH BOTH ELECTRICAL AND MECHANICAL INTERLOCK.
- 5. POWER SUPPLY CABLE FOR FIXED FIRE PUMPS, FIRE ALARM BELLS AND F.S. / MFA CONTROL PANEL SHALL BE OF FIRE RESISTING TYPE IN ACCORDANCE WITH THE LATEST FSD CIRCULAR LETTER FOR MINIMUM FIRE RESISTING CABLE REQUIREMENTS FOR FIRE SERVICE INSTALLATIONS.
- 6. THE BACKFLOW PREVENTER SHALL BE APPROVED BY THE WATER AUTHORITY.
- 7. THE PILOT-OPERATED TYPE PRESSURE REDUCING VALVE SHALL BE APPROVED / ACCEPTED BY THE WATER AUTHORITY AND FIRE SERVICES DEPARTMENT.
- 8. TO PREVENT IMPROPER USE OF THE HOSE REEL, VISUAL AND AUDIBLE WARNING INDICATION SHALL BE PROVIDED IN THE F.S. / MFA CONTROL PANEL UPON ACTUATION OF THE FLOW SWITCH. THE FLOW SIGNAL AS INDICATED ON THE F.S. / MFA CONTROL PANEL SHALL BE INDEPENDENT FROM THE FIRE ALARM SIGNAL ACTUATED BY MANUAL FIRE ALARM CALL POINT(S)
- 9. FIRE ALARM BELL SHALL BE ACTUATED UPON ACTUATION OF THE MANUAL FIRE ALARM CALL POINT / FLOW SWITCH.
- 10. ALL F.S. INSTALLATIONS SHALL BE INSTALLED WITHIN THE LOT BOUNDARY.
- 11. THE SIZE AND LOCATION OF WATER CHECK METER FOR F.S. WATER SUPPLY SHALL BE DETERMINED BY WSD.
- 12. THE PLUMBING SYSTEM OF FIRE SERVICE INSTALLATIONS IS SUBJECT TO THE REQUIREMENTS OF WATER AUTHORITY.
- 13. THE ELECTRICAL INSTALLATION WORKS SHALL COMPLY WITH THE ELECTRICITY ORDINANCE AND THE POWER COMPANY'S SUPPLY RULES.
- 14. ALL ASSOCIATED BUILDING WORKS OF FIRE SAFETY IMPROVEMENT WORKS ARE SUBJECT TO THE CONTROL UNDER BUILDINGS ORDINANCE. APPROVAL AND CONSENT FROM BUILDING AUTHORITY FOR SUCH WORKS (IF ANY) SHALL BE OBTAINED PRIOR TO COMMENCEMENT OF THE BUILDING WORKS, EXCEPT FOR THOSE BUILDING WORKS WHICH ARE UNDER THE CONTROL OF THE MINOR WORKS CONTROL SYSTEM.

#### LEGEND

SYMBOL DESCRIPTION				
GATE VALVE (N/O)				
<b>H</b>	GATE VALVE (N/C)			
\$	GATE VALVE C/W ELECTRICALLY MONITORING DEVICE (N/O)			
	GATE VALVE C/W ELECTRICALLY MONITORING DEVICE (N/C)			
$\triangleright$	NON-RETURN VALVE			
WW	FLEXIBLE PIPE CONNECTOR			
AAV	AUTOMATIC AIR VENT			
<del></del>	CHECK METER POSITION			
	HOSE REEL			
	FIRE ALARM BELL			
•	MFA CALL POINT (BREAK GLASS TYPE)			
	FIXED FIRE PUMP			
<b>⊘</b> ¥	PRESSURE GAUGE			
Р	PRESSURE SWITCH			
PRESSURE SWITCH ASSEMBLY  FS MFA F.S. / MFA CONTROL PANEL  PUMP FIXED FIRE PUMP CONTROL PANEL  PIPE RISER				
		S	S FUSED SPUR UNIT	
		NEW PIPE / CABLE / EQUIPMENT		
		EXISTING PIPE / CABLE / EQUIPMENT		
$\overline{}$	BALL FLOAT VALVE			
	3mm ORIFICE PLATE  AUTOMATIC CHANGOVER SWITCH C/W			
	ELECTRICAL & MECHANICAL INTERLOCK kWh METER			
O) MCCB / MCB UNIT				
° 9 FUSED SWITCH				
ISOLATING SWITCH				
MS	MOTOR STARTER			
M FIXED FIRE PUMP MOTOR				
$\overline{}$	STRAINER			
	BACKFLOW PREVENTER			

	ABBREVIATIONS			
	RFSIC	REGISTERED FIRE SERVICE INSTALLATIONS CONTRACTOR		
	FSI	FIRE SERVICE INSTALLATIONS		
	HR	HOSE REEL		
	MFA	MANUAL FIRE ALARM		
	AFFL	ABOVE FINISHED FLOOR LEVEL		
	H/L	HIGH LEVEL		
	M/L	MIDDLE LEVEL		
	T/A	TO ABOVE		
	T/B	TO BELOW		
	F/A	FROM ABOVE	,	
	F/B	FROM BELOW	BL	
	N/O	NORMALLY OPEN		
\	N/C	NORMALLY CLOSED		
	SP	SINGLE POLE		
	TPN	TRIPLE POLE & NEUTRAL		
	MCB	MINIATURE CIRCUIT BREAKER		
	MCCB	MOULDED CASE CIRCUIT BREAKE	R	
	C/W	COMPLETED WITH		
	S.W.	SWITCH		
	EX.	EXISTING		

FUK CHAK STREET	ANCHOR STREET
KA SHIN STREET	BEEGN STREET
PO MAN STREET	
BLOCK PLAN	(N.T.S.)

NO. 42 TAI KOK TSUI ROAD

#### LEGEND

B.L.

PRV

SYMBOL	DESCRIPTION
PRESSURE REDUCING VALVE	
F	FLOW SWITCH

PRESSURE REDUCING VALVE

#### \_\_\_\_\_

Ø25mm

Ø40mm

	00E E0D DIDE	21750	
COLOUR CODE FOR PIPE SIZES			
DIDE SIZE	COLOUR CODE	SAMPLE	
	COLOGIT CODE		

**GREEN** 

**PURPLE** 

**BOUNDARY LINE** 

PILOT-OPERATED

**Guidance Notes:** 

1. Colour code shall be aligned with section 3.6.1(d) of FSD Circular Letter No. 4/96.

SPACE RESERVED FOR FSD APPROVAL CHOP Min. (60mm x 45mm)

REV.	DESCRIPTION	DATE
0	1ST SUBMISSION	3.1.2024
А	2ND SUBMISSION	6.7.2024

FSI CONTRACTOR / -CONSULTANT

ABC FIRE ENGINEERING COMPANY LIMITED

ADDRESS: UNIT 01, 10/F.,
XXX YYY COMMERCIAL BUILDING,
TAI KOK TSUI, KOWLOON
TEL.: XXXX XXXX

PROJECT TITLE:

FIRE SAFETY IMPROVEMENT WORKS FOR NO. 42 TAI KOK TSUI ROAD, KOWLOON

DRAWING TITLE:
F.S. NOTES, LEGEND,
ABBREVIATIONS, COLOUR CODE
FOR PIPE SIZES &
BLOCK PLAN

SCALE:


N.T.S.


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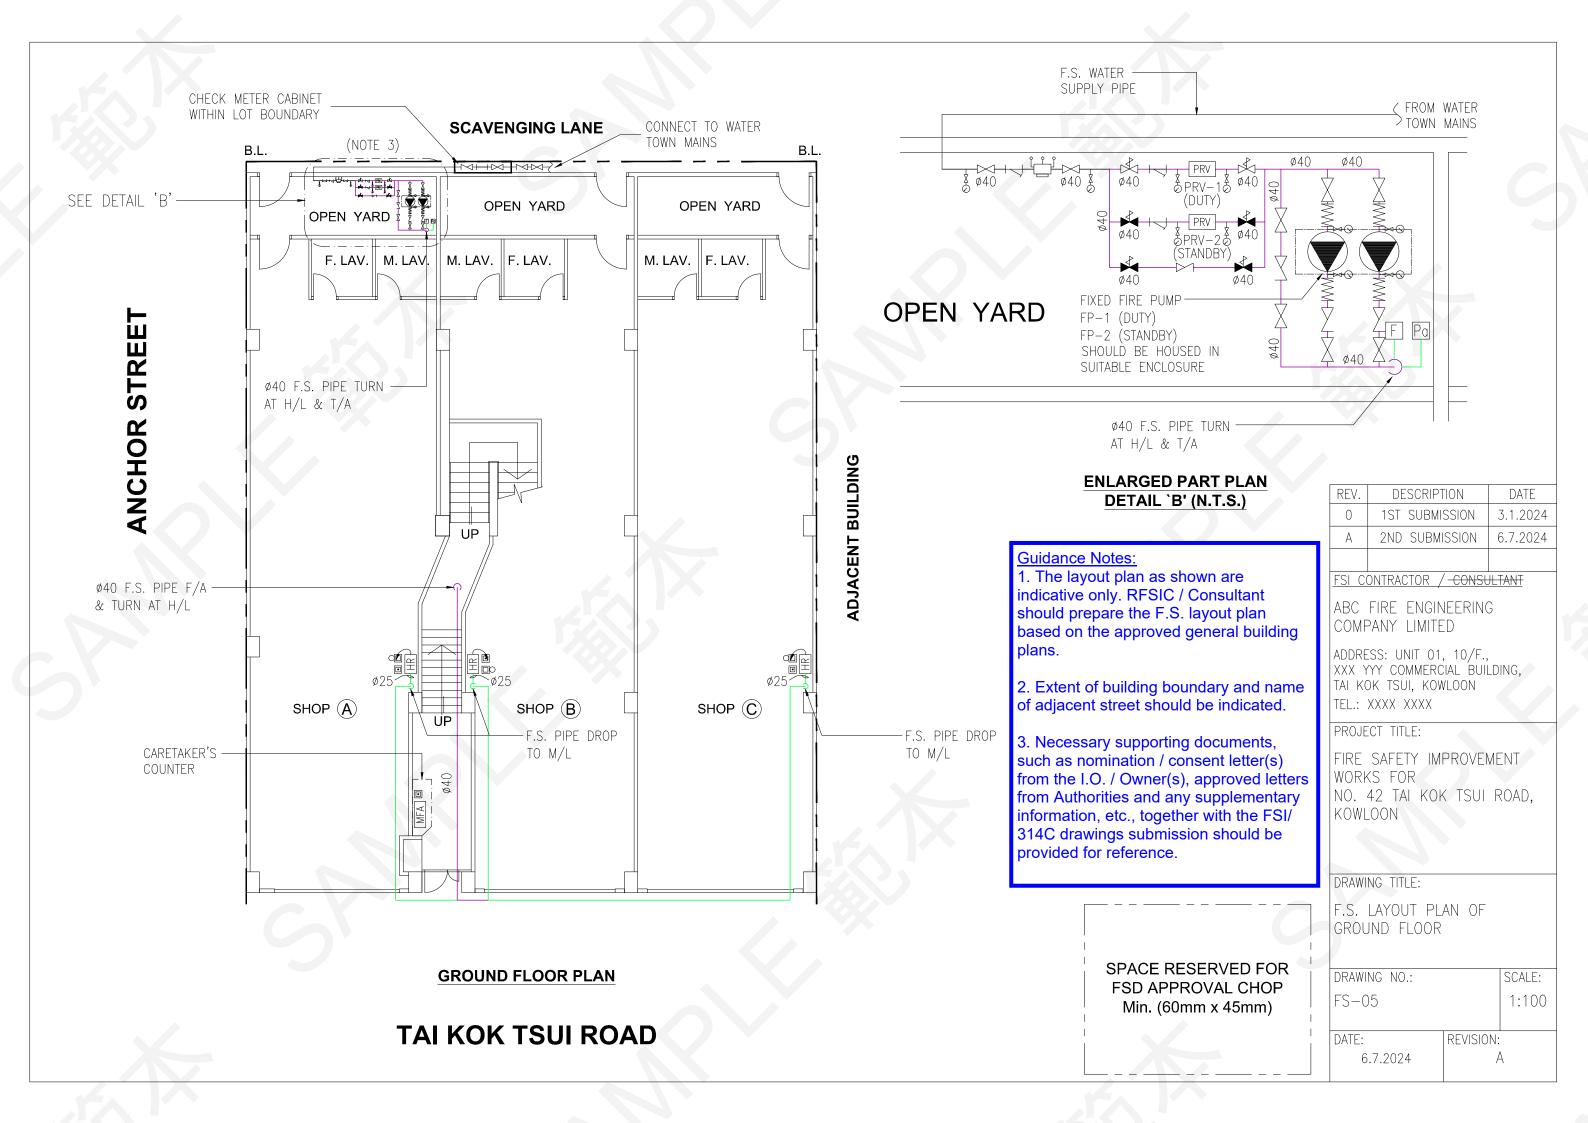
DATE: REVISION:


6.7.2024 A

#### **Guidance Notes:** 1. Prior approval from FSD for adopting improvised hose reel system (direct pumping design) shall be obtained. **FIXED FIRE PUMP SCHEDULE** 2. Size of F.S. water supply pipe from town mains **ROOF** and check meter position to be determined by **DUTY PUMP** STANDBY PUMP **PUMP** $\nabla$ **DESIGNATION** (FP-1) (FP-2) 3. Floor to floor height should be specified according to general building plan. PUMP HEAD (BAR) 4. Technical data of fixed fire pumps and pilot-TECHNICAL DATA TO BE 5TH DESIGNED BY RFSIC / FLOW RATE (L/min.) operated PRVs to be designed by RFSIC / **FLOOR** CONSULTANT Consultant. $\bigvee$ **MOTOR RATING** 5. Jockey pump may be provided if applicable. 6. Product catalogue of backflow preventer and pilot-operated PRV shall be provided together SPACE RESERVED FOR with the FSI/314C drawing submission. PRV EQUIPMENT SCHEDULE **FSD APPROVAL CHOP** 7. Hydraulic calculations for the selection of fixed 4TH **FLOOR** fire pumps and pilot-operated PRVs shall be Min. (60mm x 45mm) OUTLET MODEL NO. PRV MANU- $\nabla$ provided as separate A4 sheet in the supporting **PRESSURE DESIGNATION FACTURER** / SIZE MAINTAINED documents. 8. Cavitation in the pilot-operated PRV should be PRV-1 TECHNICAL DATA TO BE (DUTY) avoided in the equipment selection. DESIGNED BY RFSIC / 3RD PRV-2 CONSULTANT **FLOOR** (STANDBY) DATE REV. DESCRIPTION $\nabla$ 1ST SUBMISSION 3.1.2024 2ND SUBMISSION 6.7.2024 FSI CONTRACTOR / CONSULTANT 2ND **FLOOR** ABC FIRE ENGINEERING $\nabla$ COMPANY LIMITED Ø40 ADDRESS: UNIT 01, 10/F., XXX YYY COMMERCIAL BUILDING. THE GATE VALVE OF THE WATER SUPPLY TAI KOK TSUI. KOWLOON SHALL BE PROPERLY SECURED AND LOCKED 1ST TEL.: XXXX XXXX IN AN OPEN POSITION AT ALL TIMES TO B.L. **FLOOR** PREVENT UNAUTHORIZED TAMPERING. PROJECT TITLE: $\bigvee$ FIRE SAFETY IMPROVEMENT PRESSURE SWITCH ASSEMBLY -WORKS FOR (THE ARRANGEMENT TO BE CHECK METER NO. 42 TAI KOK TSUI ROAD, DESIGNED BY RFSIC/CONSULTANT) POSITION FOR KOWLOON F.S. WATER (NOTE 5) Ø25 Ø40 Ø25 DRAWING TITLE: SCHEMATIC PIPING DIAGRAM FOR HOSE REEL SYSTEM Pa F Ø<u>25</u> ₩ Ø<u>25</u> ₩ Ø25 **GROUND** DRAWING NO.: SCALE: **FLOOR** TO DRAIN $\bigvee$ FS-02 N.T.S. F.S. WATER SUPPLY PIPE DATE: **REVISION:** TO BE CONNECTED FROM 6.7.2024 TOWN MAINS



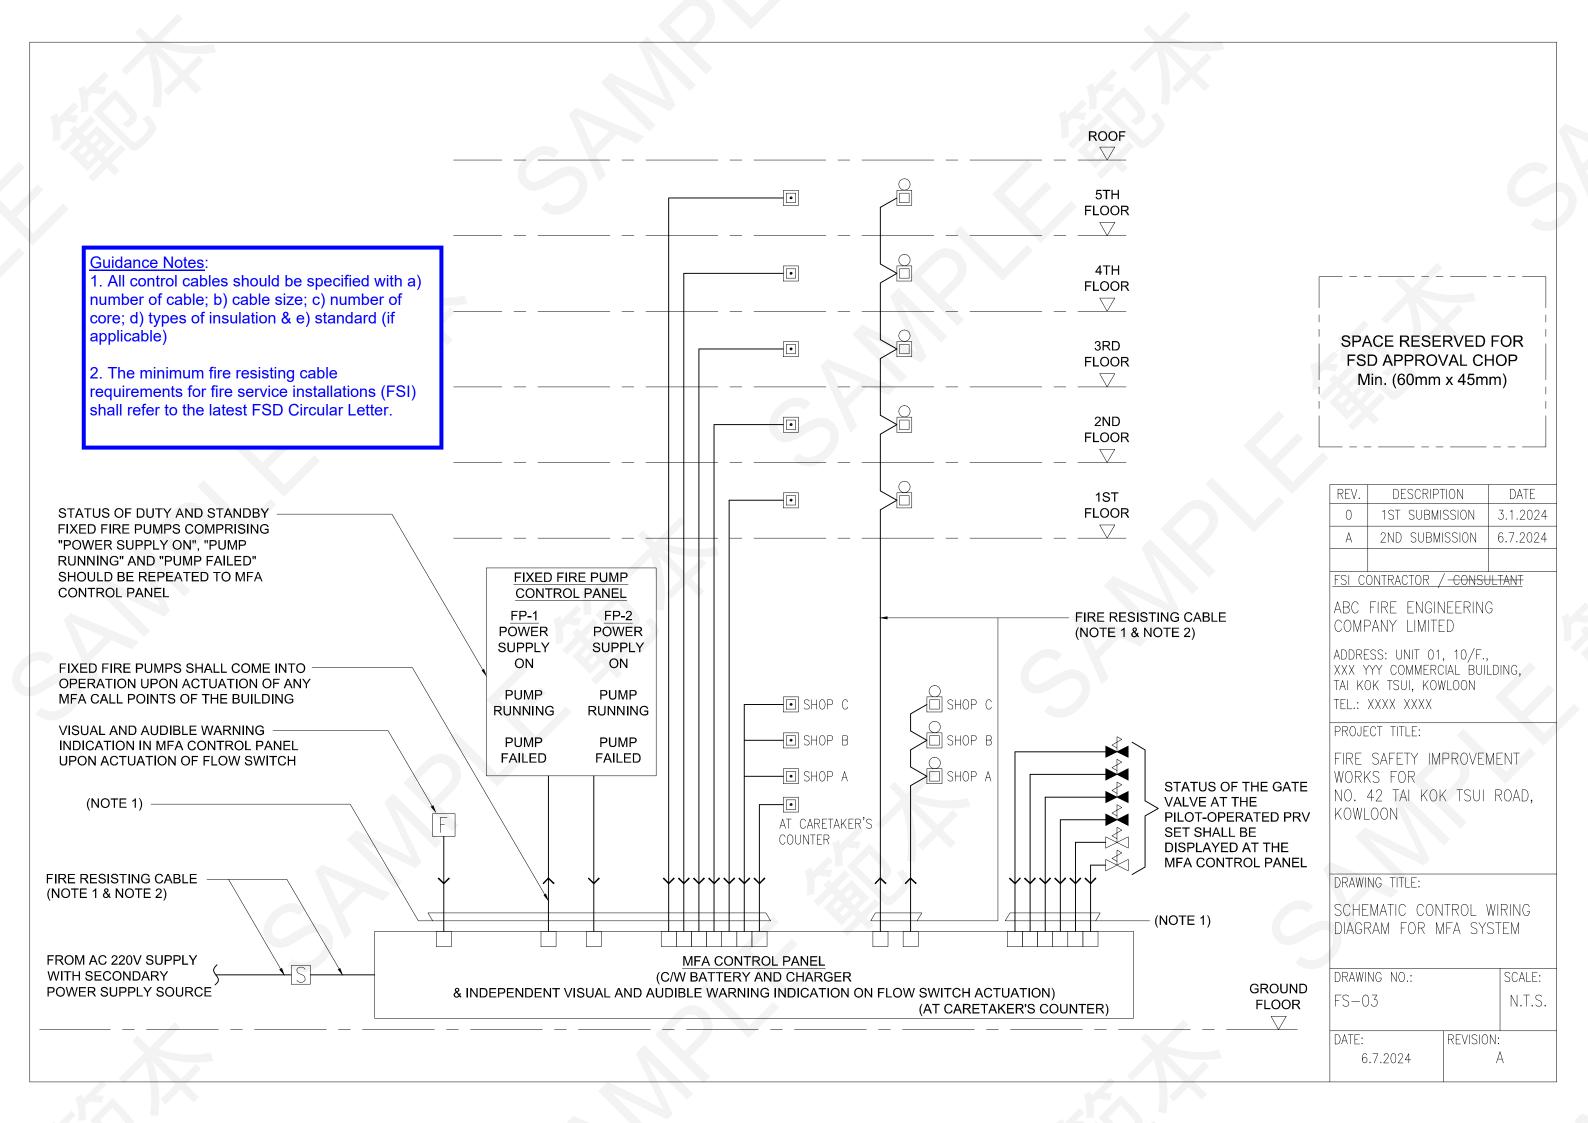

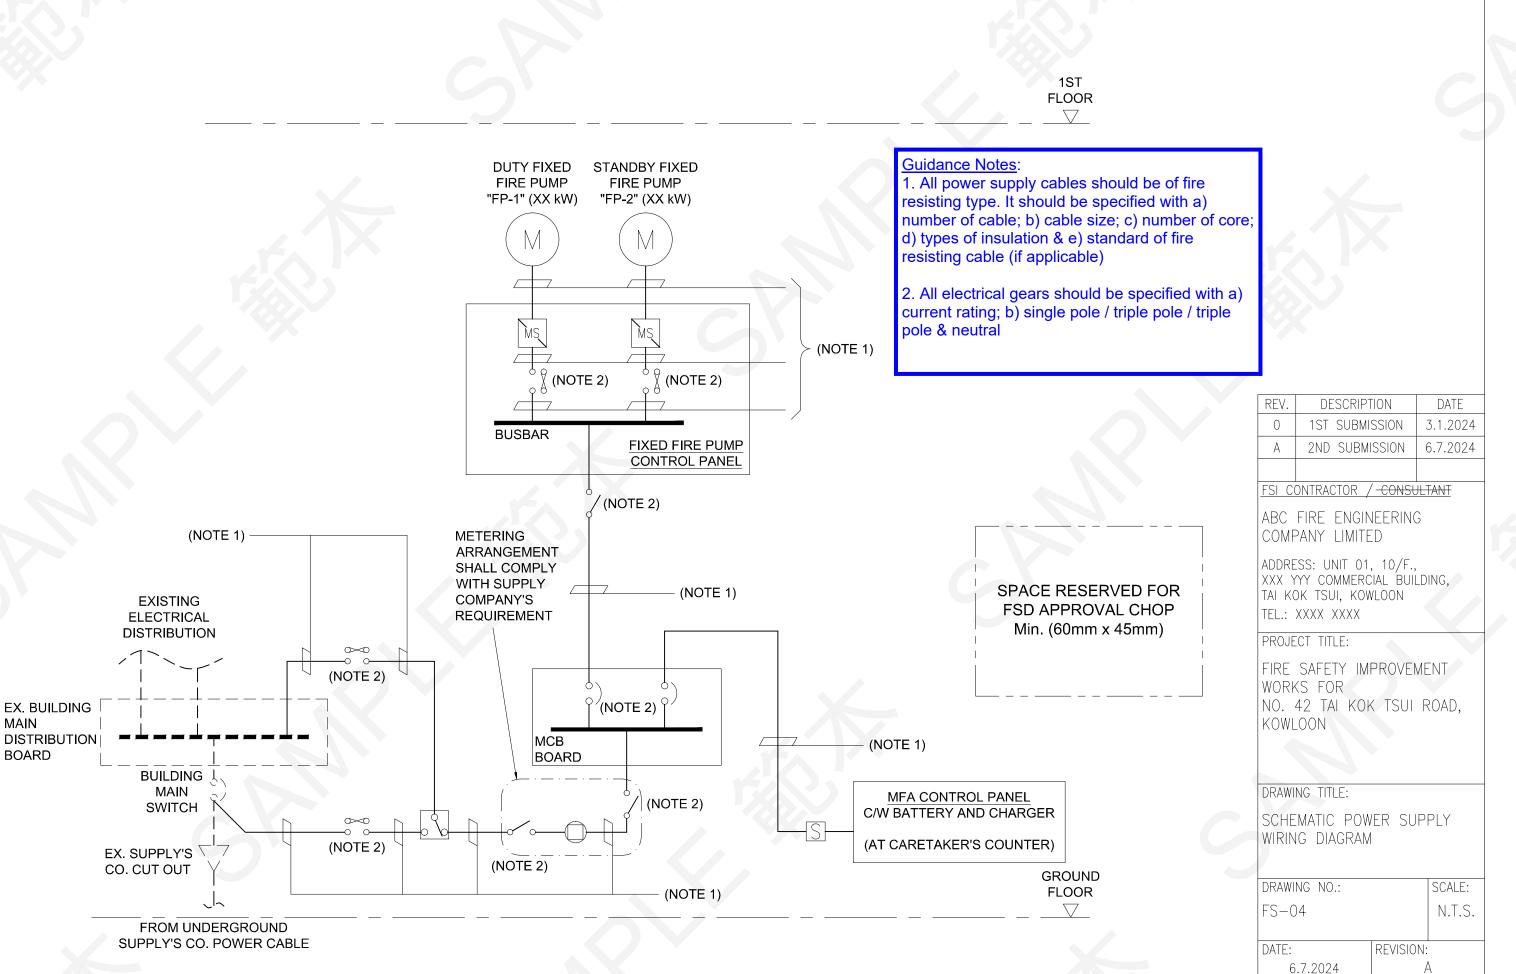

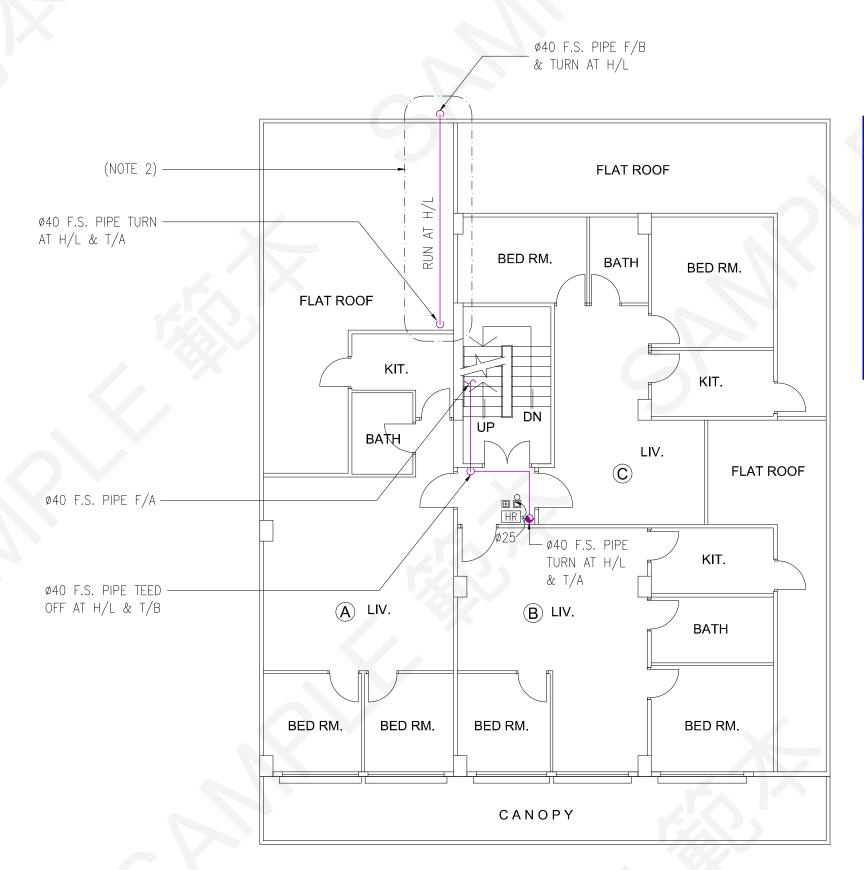

# **1ST FLOOR PLAN**

# **Guidance Notes:**

- 1. The layout plan as shown are indicative only. RFSIC / Consultant should prepare the F.S. layout plan based on the approved general building plans.
- 2. Necessary supporting documents, such as nomination / consent letter(s) from the I.O. / Owner(s), approved letters from Authorities and any supplementary information, etc., together with the FSI/314C drawings submission should be provided for reference.

SPACE RESERVED FOR

**FSD APPROVAL CHOP** 

Min. (60mm x 45mm)

REV.	DESCRIPTION	DATE
0	1ST SUBMISSION	3.1.2024
А	2ND SUBMISSION	6.7.2024

#### FSI CONTRACTOR / CONSULTANT

ABC FIRE ENGINEERING COMPANY LIMITED

ADDRESS: UNIT 01, 10/F., XXX YYY COMMERCIAL BUILDING, TAI KOK TSUI, KOWLOON TEL.: XXXX XXXX

#### PROJECT TITLE:

FIRE SAFETY IMPROVEMENT WORKS FOR NO. 42 TAI KOK TSUI ROAD, KOWLOON

#### DRAWING TITLE:

F.S. LAYOUT PLAN OF 1ST FLOOR

DRAWING NO.: FS-06


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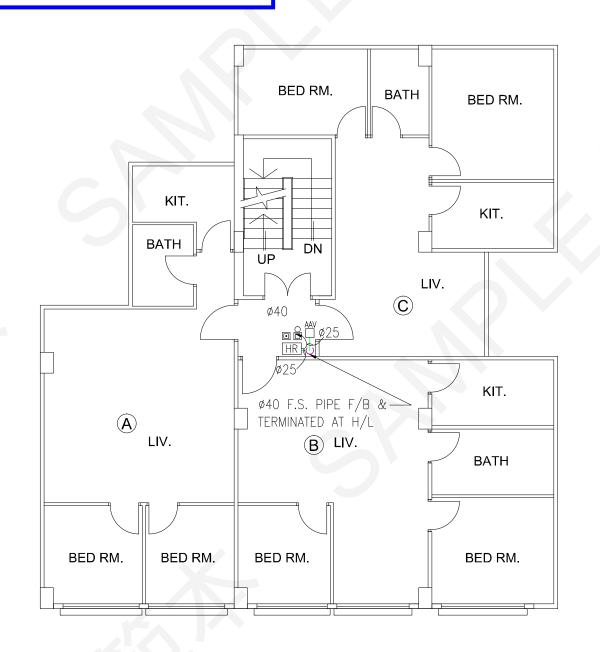
REVISION: 6.7.2024

### **Guidance Notes:**

1. The layout plan as shown are indicative only. RFSIC / Consultant should prepare the F.S. layout plan based on the approved general building plans.



2ND FLOOR TO 4TH FLOOR PLAN (TOTAL: 3 NOS. OF FLOOR)

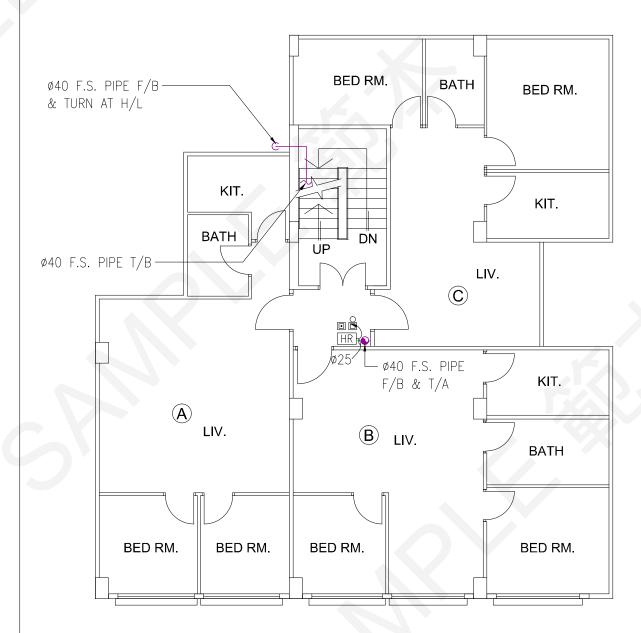

# **5TH FLOOR PLAN**

SPACE RESERVED FOR FSD APPROVAL CHOP Min. (60mm x 45mm)

REV.	DESCRIPTION	DATE
0	1ST SUBMISSION	3.1.2024
А	2ND SUBMISSION	6.7.2024

#### FSI CONTRACTOR / CONSULTANT

ABC FIRE ENGINEERING COMPANY LIMITED

ADDRESS: UNIT 01, 10/F., XXX YYY COMMERCIAL BUILDING, TAI KOK TSUI, KOWLOON TEL.: XXXX XXXX

# PROJECT TITLE:

FIRE SAFETY IMPROVEMENT WORKS FOR NO. 42 TAI KOK TSUI ROAD, KOWLOON

#### DRAWING TITLE:

F.S. LAYOUT PLAN OF 2ND FLOOR TO 4TH FLOOR AND 5TH FLOOR

DRAWING NO.: FS-07


SCALE: 1:100

DATE: REVISION:

6.7.2024

# **Guidance Notes:**

1. The layout plan as shown are indicative only. RFSIC / Consultant should prepare the F.S. layout plan based on the approved general building plans.

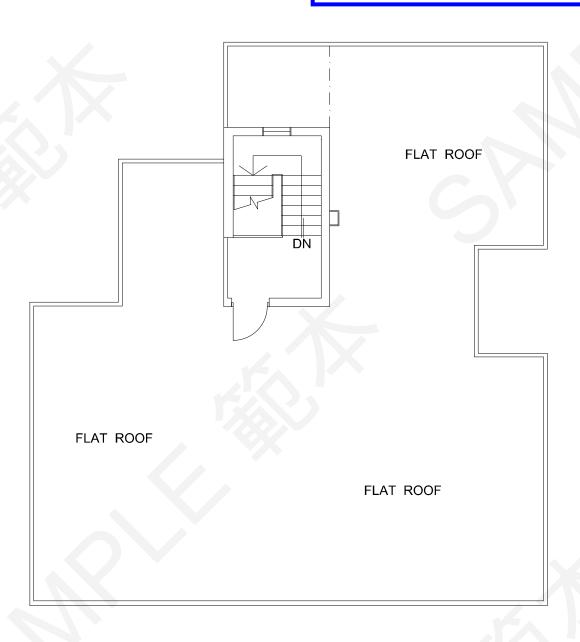

# **ROOF PLAN**

# FOR REFERENCE ONLY

REV.	DESCRIPTION	DATE
0	1ST SUBMISSION	3.1.2024
А	2ND SUBMISSION	6.7.2024

### FSI CONTRACTOR / CONSULTANT

ABC FIRE ENGINEERING COMPANY LIMITED

ADDRESS: UNIT 01, 10/F., XXX YYY COMMERCIAL BUILDING, TAI KOK TSUI, KOWLOON TEL.: XXXX XXXX

PROJECT TITLE:

FIRE SAFETY IMPROVEMENT WORKS FOR NO. 42 TAI KOK TSUI ROAD, KOWLOON

DRAWING TITLE:

F.S. LAYOUT PLAN OF ROOF

DRAWING NO.: FS-08

1:100

SCALE:

DATE: REVISION:

6.7.2024